



City of Elko Clerk's Department
1751 College Avenue
Elko, NV 89801
(775) 777-7126
FAX (775) 777-7129

ADDENDUM NUMBER ONE

6th STREET STORM DRAIN REPAIR – PHASE 2

Please confirm receipt of ADDENDUM NUMBER ONE AND FAX BACK TO (775) 777-7129 or email to cityclerk@elkocity.nv.gov.

RECEIVED:

SIGNATURE

COMPANY NAME

Dated this 29th day of June, 2018.

Elko City Clerk

Shanell Owen, MMC

***** PLEASE NOTE RECEIPT OF ADDENDUM NUMBER ONE ON
APPLICABLE LINE ON SUBMITTED BID PROPOSAL *****



CITY OF ELKO
ENGINEERING DEPARTMENT
1755 COLLEGE AVENUE
ELKO, NEVADA 89801
(775)777-7210
(775)777-7219 FAX

ADDENDUM #1
6th STREET STORM DRAIN REPAIR – PHASE 2

JUNE 29, 2018

This addendum addresses additions, changes, and clarifications to the Contract Documents and Contract Drawings for the City of Elko, 6th Street Storm Drain Repair - Phase 2.

CHANGES:

1– The existing and proposed storm drain pipe sizes are incorrect on the original plan set. The old pipe is a 48" arched CMP, the pipe installed last year is 48"Ø HDPE, and the new proposed pipe installed with this phase will also be 48"Ø HDPE. A revised plan set is attached hereto.

2 – The bid form has been revised to show the correct pipe sizes and is attached hereto.

CLARIFICATIONS

1 – The City of Elko Public Works department will assist in the connection of the new round HDPE pipe to the existing arched CMP, as noted on sheet 2 of the revised plan set, attached hereto.

Thank you for your interest in bidding this project.

Sincerely,

Bob Thibault, P.E., P.L.S.
City of Elko
Civil Engineer



CITY OF ELKO

6TH ST. STORM DRAIN REPAIR -PHASE 2


OWNER/DEVELOPER:

CITY OF ELKO
ATTN: MR. DENNIS STRICKLAND
1751 COLLEGE AVE.
ELKO, NV 89801
PH.: (775) 777-7241
FAX: (775) 774-7249

ENGINEERS



1751 COLLEGE AVE.
ELKO, NV 89801
PH.: (775) 777-7110
FAX: (775) 774-7119

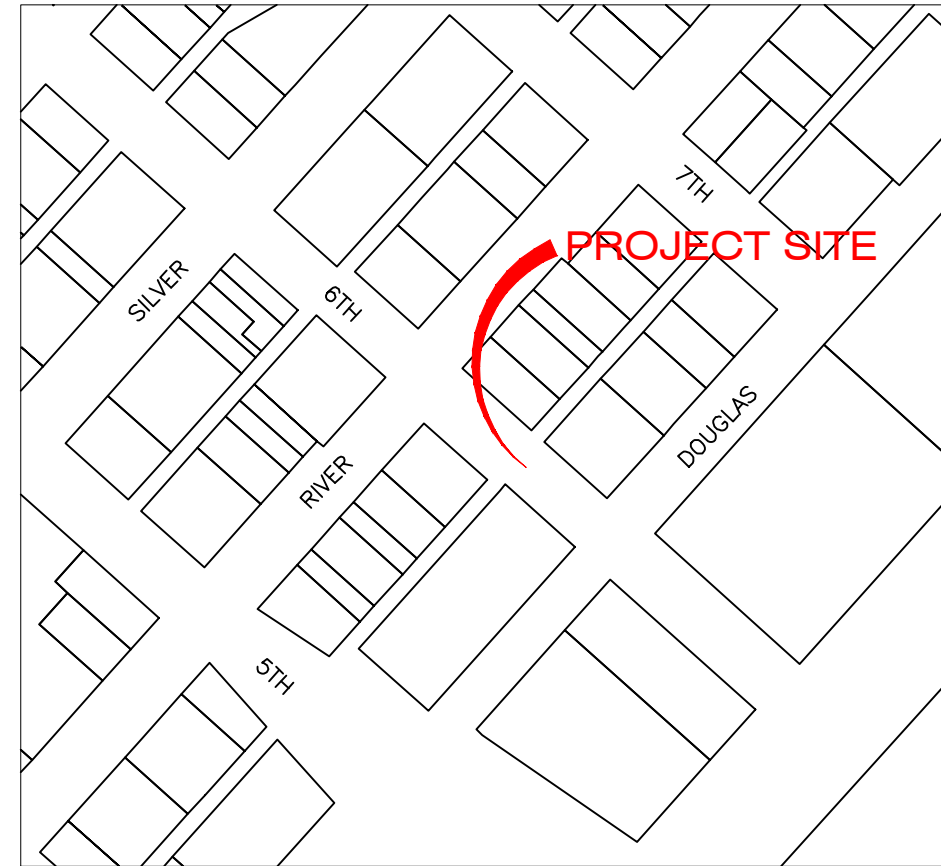

VICINITY MAP

2 working days
Call before you Dig.

1-800-227-2600

AVOID CUTTING UNDERGROUND UTILITIES

SHEET INDEX:

TITLE SHEET _____	1
SITE PLAN & PROFILE _____	2
DETAIL SHEET _____	3

GENERAL NOTES:


1. THE CONTRACTOR SHALL MAINTAIN A 24-HOUR DUST CONTROL PROGRAM INCLUDING WATERING OF OPEN AREAS. DUST CONTROL PROGRAM SHALL BE IN COMPLIANCE WITH ALL FEDERAL, STATE, COUNTY AND CITY CODES AND ORDINANCES.
2. THE CONTRACTOR SHALL MAINTAIN AN ONGOING PROCESS FOR REMOVAL OF SPILLAGE OF EXCAVATED MATERIAL ON ALL PAVED STREETS.
3. ALL CONSTRUCTION SHALL MEET THE REQUIREMENTS OF THE LATEST EDITION OF THE STANDARD SPECIFICATIONS & DETAILS FOR PUBLIC WORKS CONSTRUCTION - "ORANGE BOOK" AS PUBLISHED BY THE WASHOE COUNTY RTC.
4. ALL AREAS DISTURBED AND LEFT UNDEVELOPED FOR A PERIOD OF MORE THAN 30 DAYS SHALL BE STABILIZED BY THE APPLICATION OF A DUST PALLIATIVE. ALL AREAS LEFT UNDEVELOPED FOR A PERIOD OF MORE THAN 90 DAYS SHALL BE HYDRO-SEEDED WITH AN APPROVED SEED MIX AND TACKIFIER AND SHALL BE IRRIGATED UNTIL FIRMLY ESTABLISHED AS APPROVED BY THE CITY OF ELKO.
5. THE CONTRACTOR SHALL VERIFY IN THE FIELD, ALL ELEVATIONS, DIMENSIONS, FLOW LINES, EXISTING CONDITIONS, AND POINTS OF CONNECTIONS WITH ADJOINING PROPERTY (PUBLIC OR PRIVATE), ANY DISCREPANCIES SHALL BE CALLED TO THE ATTENTION OF THE PROJECT ENGINEER BEFORE PROCEEDING WITH THE WORK.
6. THE CONTRACTOR SHALL NOTIFY THE PROJECT ENGINEER, THE SOILS ENGINEER, THE CITY OF ELKO, AND ALL UTILITY COMPANIES 48 HOURS PRIOR TO COMMENCEMENT OF WORK.
7. THE CONTRACTOR SHALL CALL UNDERGROUND SERVICES ALERT AT 1.800.227.2600 AT LEAST 48 HOURS PRIOR TO EXCAVATION.
8. THE CONTRACTOR SHALL BE RESPONSIBLE FOR ANY AND ALL DAMAGE TO THE EXISTING UTILITIES ENCOUNTERED DURING CONSTRUCTION. IT SHALL BE THE CONTRACTOR'S RESPONSIBILITY TO CONTACT THE UTILITY COMPANIES FOR LOCATIONS PRIOR TO CONSTRUCTION. HORIZONTAL AND VERTICAL LOCATIONS OF EXISTING UTILITIES ARE APPROXIMATE ONLY.
9. CONTRACTOR TO OBTAIN A STREET CUT PERMIT FROM THE PUBLIC WORKS DEPARTMENT AND PAY ANY APPLICABLE FEES TO THE CITY OF ELKO PRIOR TO EXCAVATING WITHIN THE CITY RIGHT OF WAY.
10. AT ALL POINTS WHERE SEWER (SANITARY OR STORM), WATER MAINS AND LATERALS CROSS, VERTICAL AND HORIZONTAL SEPARATION SHALL BE MAINTAINED PER NAC. ENGINEER AND CONTRACTOR TO REFERENCE SECTION 445A.6715 TO SECTION 445A.6718 OF THE NEVADA ADMINISTRATIVE CODE FOR UTILITY SEPARATION AND CLEARANCES.
11. A TRAFFIC CONTROL PLAN SHALL BE PROVIDED BY THE CONTRACTOR AND APPROVED BY THE CITY OF ELKO PRIOR TO CONSTRUCTION.
12. ALL CONCRETE PLACED IN THE CITY OF ELKO RIGHT OF WAY SHALL COMPLY WITH THE LATEST EDITION OF THE ORANGE BOOK AND SHALL BE A CITY APPROVED MIX DESIGN.

BASIS OF BEARING:

NORTH AMERICAN DATUM OF 1983/2007 PER THE NATIONAL GEODETIC SURVEY'S (NGS) PUBLISHED COORDINATES FOR NGS STATION "FUZZY", A STANDARD BRONZE DISK STAMPED "FUZZY 1957" SET IN THE TOP OF A ROUND CONCRETE POST WHICH PROJECTS 2 INCHES ABOVE THE GROUND, OF LATITUDE 40° 54' 25.01325"N, LONGITUDE 115° 41' 47.52810"W AND NEVADA STATE PLANE COORDINATE SYSTEM EAST ZONE GRID COORDINATES OF 28,488,522.75N, 624,878.27E. GROUND COORDINATES ARE USED HEREIN AND REFLECT GRID COORDINATES MULTIPLIED BY THE CITY OF ELKO ACCEPTED COMBINED GRID TO GROUND SCALE FACTOR OF 1.000357 WITH THE RESULTING GROUND COORDINATES FOR NGS "FUZZY" BEING 28,498,693.15N, 625,101.35E.

BASIS OF ELEVATION:

NORTH AMERICAN VERTICAL DATUM OF 1988, PER THE NATIONAL GEODETIC SURVEY'S (NGS) PUBLISHED ELEVATION FOR NGS BENCHMARK B 52, A STABILITY CLASS A MARK STAMPED "B 52 1934" SET VERTICALLY IN THE NORTHWEST WALL OF THE ELKO MAIN POST OFFICE (BRICK WITH STONE CORNERS), 0.9 FOOT SOUTHWEST OF THE NORTH CORNER, AND 4 FEET ABOVE THE GROUND.

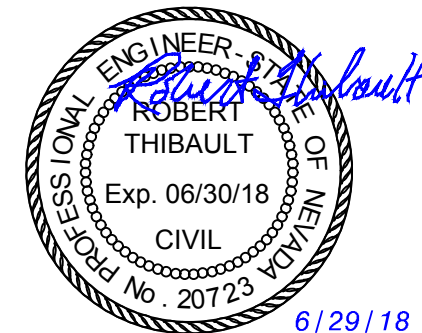

CITY OF ELKO
 1751 COLLEGE AVE
 ELKO, NEVADA 89801
 775-777-7210

SCALE

HORZ _____ NONE _____
 VERT _____ NONE _____




DESIGNED BY _____ JJ _____
 DRAWN BY _____ ACAD 2017 _____
 CHECKED BY _____ BT _____
 DATE _____ 6/29/2018 _____

CITY OF ELKO
6TH ST. STORM DRAIN REPAIR - PHASE 2
TITLE SHEET

SHEET 1
OF 3

NOTES:

- 1) CONTRACTOR TO IMPORT, PLACE, AND COMPACT 12" OF AGGREGATE BASE FOR TOP LIFT OF BACKFILL, TO MATCH EXISTING ASPHALT GRADES. CITY WILL REMOVE TOP 3" OF BASE AND PERFORM ASPHALT PATCHING AFTER CONSTRUCTION.
- 2) SAWCUTTING OF ASPHALT IS NOT REQUIRED.
- 3) 72" CMP WILL BE PROVIDED BY THE CITY OF ELKO.

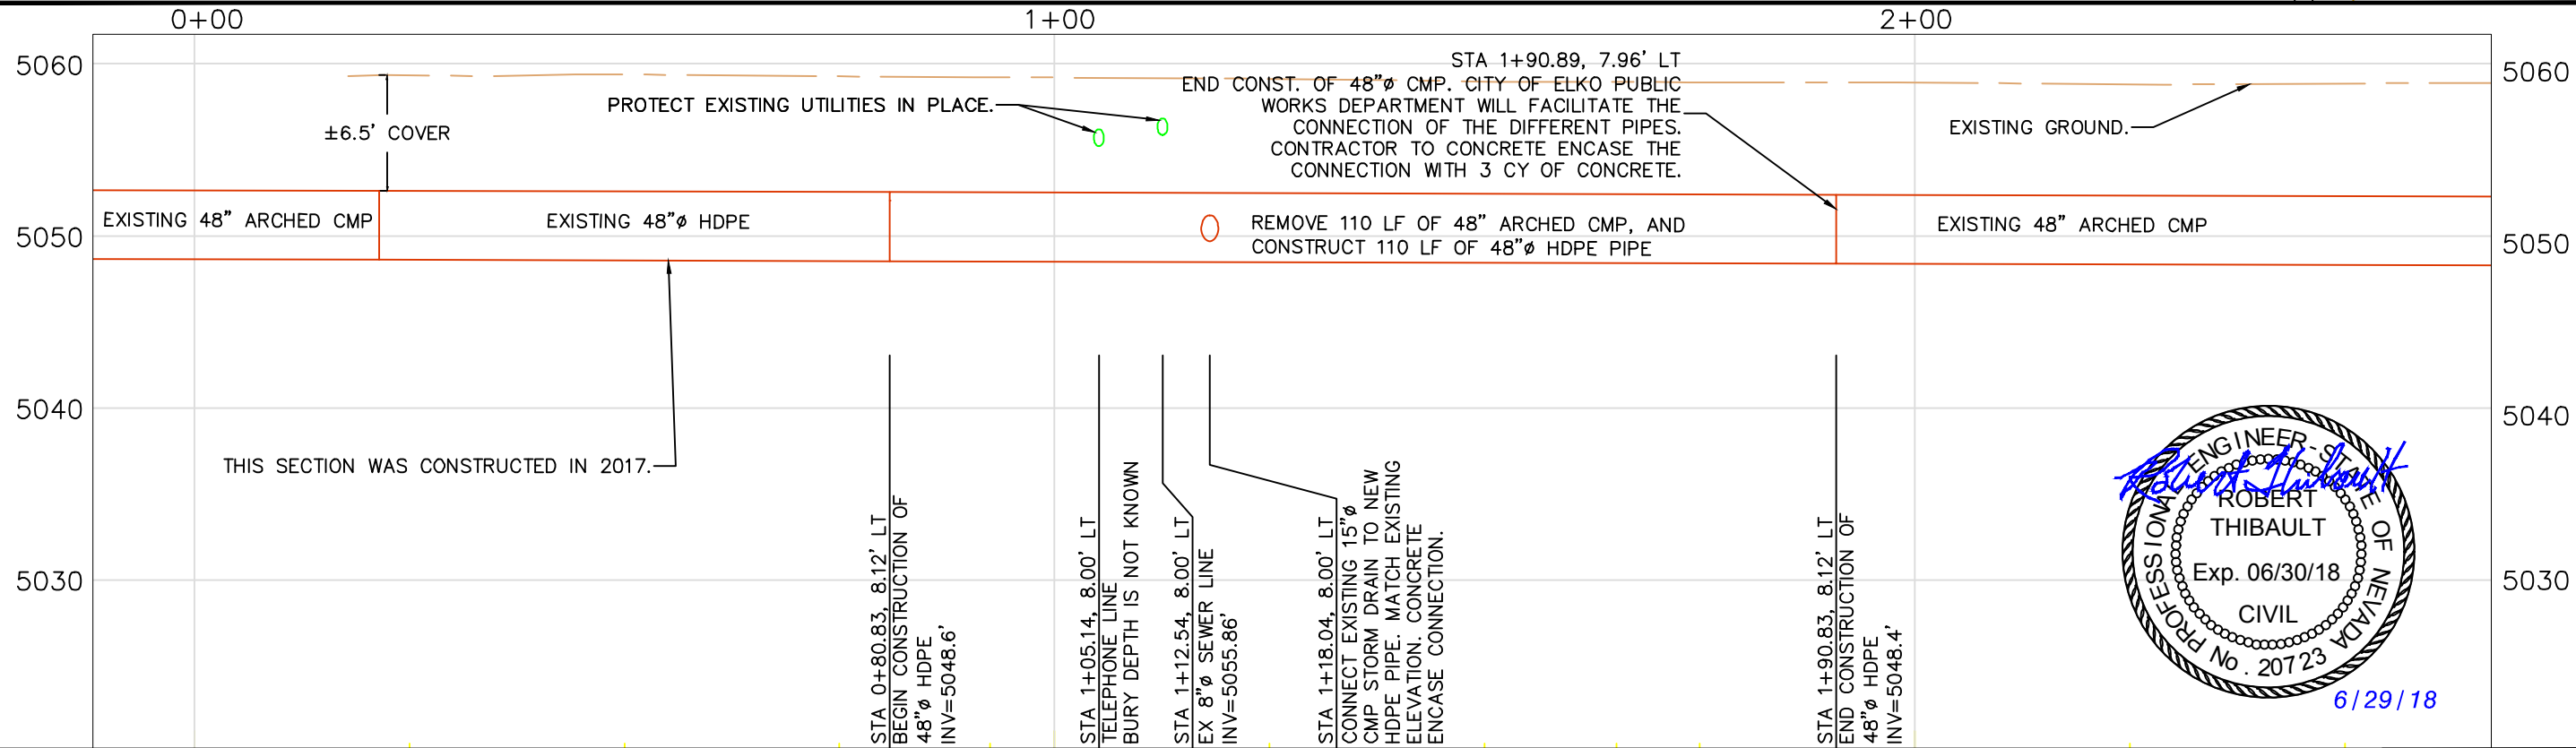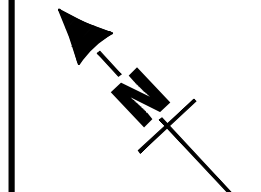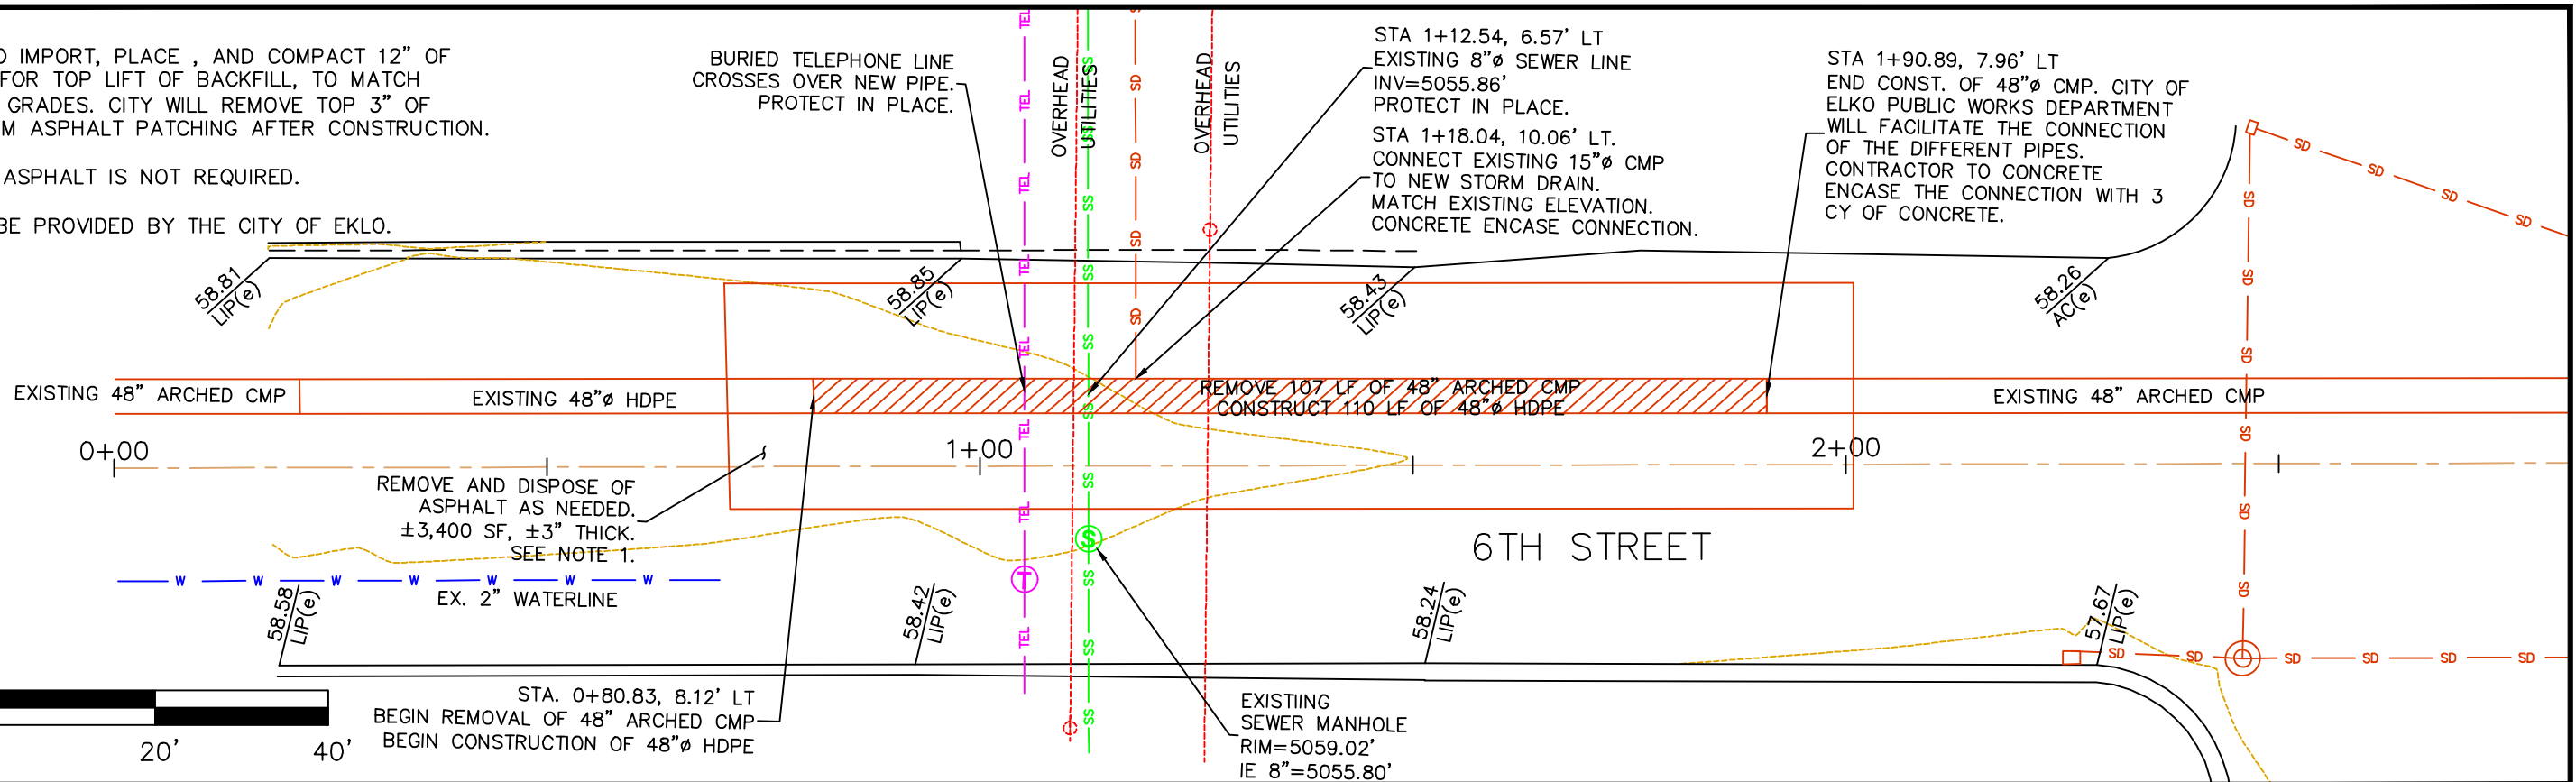


CITY OF ELKO
1751 COLLEGE AVE
ELKO, NEVADA 89801
775-777-7210

SCALE
 HORZ 1"=20'
 VERT 1"=10'

DESIGNED BY JJ
 DRAWN BY ACAD 2017
 CHECKED BY BT
 DATE 6/29/2018

CITY OF ELKO
 6TH ST. STORM DRAIN REPAIR – PHASE 2
 PLAN AND PROFILE

SHEET 2
OF 3

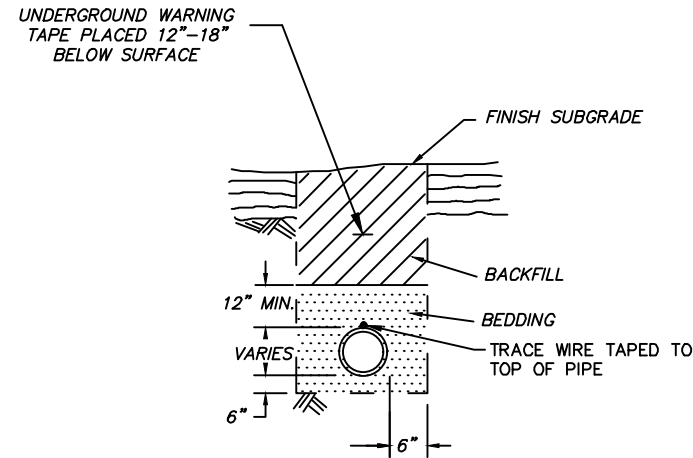


DUCTILE IRON PIPE, PVC, PE & HDPE PIPE

NOTES:

1. WATER DENSIFIED BACKFILL AND TUNNELING SHALL NOT BE ALLOWED.
2. BACKFILL SHALL MEET THE REQUIREMENTS FOR CLASS "E" BACKFILL WITH NO ROCKS SIZED OVER 4", COMPACTED IN 6" (MAX.) LIFTS TO 90% (MIN.) RELATIVE COMPACTION.
3. BEDDING MATERIAL FOR THE FOLLOWING PIPE SHALL MEET THE REQUIREMENTS OF SECTION 200 & 305 OF THE LATEST EDITION OF THE STANDARD SPECIFICATIONS FOR PUBLIC WORKS CONSTRUCTION AND COMPACTED TO A MINIMUM 90% RELATIVE COMPACTION.
 - A) DUCTILE IRON PIPE - CLASS "C"
 - B) ALL OTHER PIPE - CLASS "A"
4. FOR TRENCHES & EXCAVATIONS LOCATED WITHIN ROADWAY SECTION, SEE PAVEMENT PATCH DETAIL.
5. ALL TRENCHES AND EXCAVATIONS SHALL CONFORM TO THE LATEST EDITION OF O.S.H.A. AND M.U.T.C.D. REQUIREMENTS.
6. NATIVE MATERIAL MUST BE APPROVED BY THE CITY OF ELKO ENGINEER PRIOR TO USING AS BACKFILL OR BEDDING.
7. UNDERGROUND WARNING TAPE SHALL BE METALLIC AND APPROPRIATLY LABELED AND COLORED.


TRENCH EXCAVATION & BACKFILL

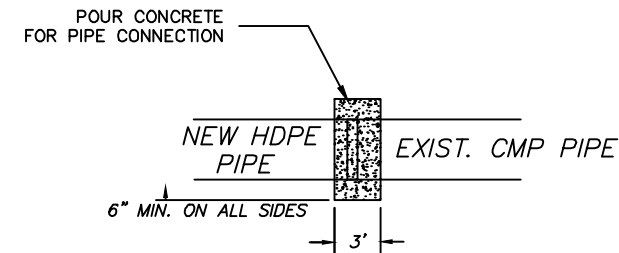

NOTES:

1. CONCRETE ENCASE PIPE CONNECTION WITH MINIMUM 1.5' OVER EACH PIPE AND MINIMUM 6" THICK ON ALL SIDES.

CONCRETE PIPE CONNECTION

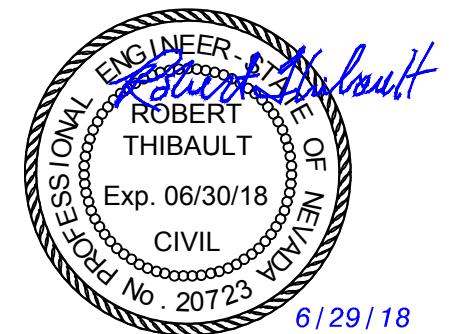

CITY OF ELKO
 1751 COLLEGE AVE
 ELKO, NEVADA 89801
 775-777-7210

SCALE
 HORZ 1"=20'
 VERT none

DESIGNED BY JJ
 DRAWN BY ACAD 2017
 CHECKED BY BT
 DATE 6/29/2018

CITY OF ELKO
 6TH ST. STORM DRAIN REPAIR - PHASE 2
 DETAILS

SHEET 3
 OF 3



4.0 EXHIBITS

EXHIBIT 1 – REVISED BID FORM 06/29/18

THIS FORM, FULLY COMPLETED, MUST BE USED FOR ALL BIDS

TO THE CITY OF ELKO, NEVADA:

The undersigned bidder hereby offers, in the amount stated in Exhibit 1 – Bid Form, to furnish all labor, materials, tools, equipment, apparatus, facilities, transportation, incidental items and permits (except as otherwise stated in the Contract Documents) for the construction of the Project, described as follows:

**THE CITY OF ELKO
 6TH STREET STORM DRAIN REPAIR – PHASE 2**

The bidder agrees that the work will be performed in accordance with the Contract Documents together with incidental items necessary to complete the work to be constructed in accordance with the Contract, any and all Exhibits to the Contract, Exhibit 16 – Technical Specifications, Exhibit 8 – Project Construction Plans and also in accordance with the "Standard Specifications and Details for Public Works Construction", 2016 Revised Edition, and amendments (Orange Book) as adopted by the City of Elko, Nevada.

Item No. & Work Description	Quantity	Unit	Unit Price	Bid Amount
1. Mobilization @ _____ _____ per Lump Sum.	1	LS		
2. Traffic Control @ _____ _____ per Lump Sum.	1	LS		
3. Remove and Dispose of Asphalt @ _____ _____ per Square Foot.	3,400	SF		
4. Remove and Dispose of 48" Arched CMP @ _____ _____ per Lineal Foot.	110	LF		
5. Construct 48"Ø HDPE Pipe @ _____ _____ per Lineal Foot.	110	LF		



6. Import, Place, and Compact Aggregate Base @ _____ per Cubic Yard.	126	CY		
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TOTAL BASE BID AMOUNT (BID ITEMS NO. 1 – NO. 6) IN NUMBERS =

\$ _____

TOTAL BASE BID AMOUNT (BID ITEMS NO. 1 – NO. 6) IN WRITTEN FORM =

BASE BID INSTRUCTIONS: The Base Bid amount is to be stated in legible figures only and is the total amount bid for the entire contract work, including all applicable taxes. Any alteration, erasure or change must be clearly indicated and initialed by the bidder. The bidder agrees that the following, without limitation, may, in the City's discretion, constitute grounds for rejecting this bid as non-responsive: (1) one or more blanks are not filled in; (2) the bid form is not signed by an authorized representative of the bidder; (3) any words or figures are not legible; (4) there are discrepancies in the figures (to include arithmetical errors); (5) the bid is not submitted with a compliant bid bond; (6) the bidder supplies false information on this bid form; or (7) the bidder fails to provide information required by this bid form or Nevada law.

COMMUNICATIONS WITH CITY: All communications with the City regarding this Project until the time a contract is executed by the City shall be directed to the Office of the Elko City Clerk. In the event the City determines that a bidder has attempted to communicate with any City official or employee in violation of the preceding sentence, the City may, in its discretion, reject that bid (even after a Notice of Award has been issued) on the ground that rejection of the bid serves the public interest.

CERTIFICATION OF FAMILIARITY WITH PROJECT AND CONTRACT REQUIREMENTS:

The bidder certifies that it has inspected the location where the Project will be performed, has read and is thoroughly familiar with the Project and the Contract documents, and has received and thoroughly reviewed the following Addenda and/or other documents from the City in relation to this Project: _____

